

Metropolitan

Communications Group A-2015-2475348

#fiber engineering #construction #splicing

April 3, 2015

PA Public Utility Commission ATTN: Ms. Rosemary Chiavetta Secretary P.O. Box # 3265 Harrisburg, PA 17105-3265 RECEIVED

APR 06 2015

PA PUBLIC UTILITY COMMISSION SECRETARY'S BUREAU

Re: XO Communications - AARDOT 517721G East Lampeter Township, Lancaster County

Ms. Chiavetta,

Metropolitan Communications Group (MCG) has been retained by XO Communications to provide project management and engineering services for a proposed fiber build in East Lampeter Township, Lancaster County.

Enclosed is an application to the PUC for XO Communications to rearrange aerial cables crossing the Norfolk Southern Railroad on Greenfield Road at Crossing # 517721G.

If you have any questions or need additional information please do not hesitate to contact me at (610) 241-6788.

Sincerely,

Dave McEvoy
OSP Engineer

Metropolitan Communications Group

910 Camaro Run Drive West Chester, PA 19380

(610) 696-6910 (610) 241-6788

APR 06 2015

PA PUBLIC (ITILITY COMMISSION SECRETARY'S BUREAU



GREENFIELD ROAD POLE RELOCATION LANCASTER, PA LANCASTER COUNTY DESIGN

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CUSTOMER APPROVAL


BY: ______

PREPARED BY




910 Camaro Run Drive, West Chester, PA 19380 Office: (610) 696-6910 - Fax: (610) 696-6937



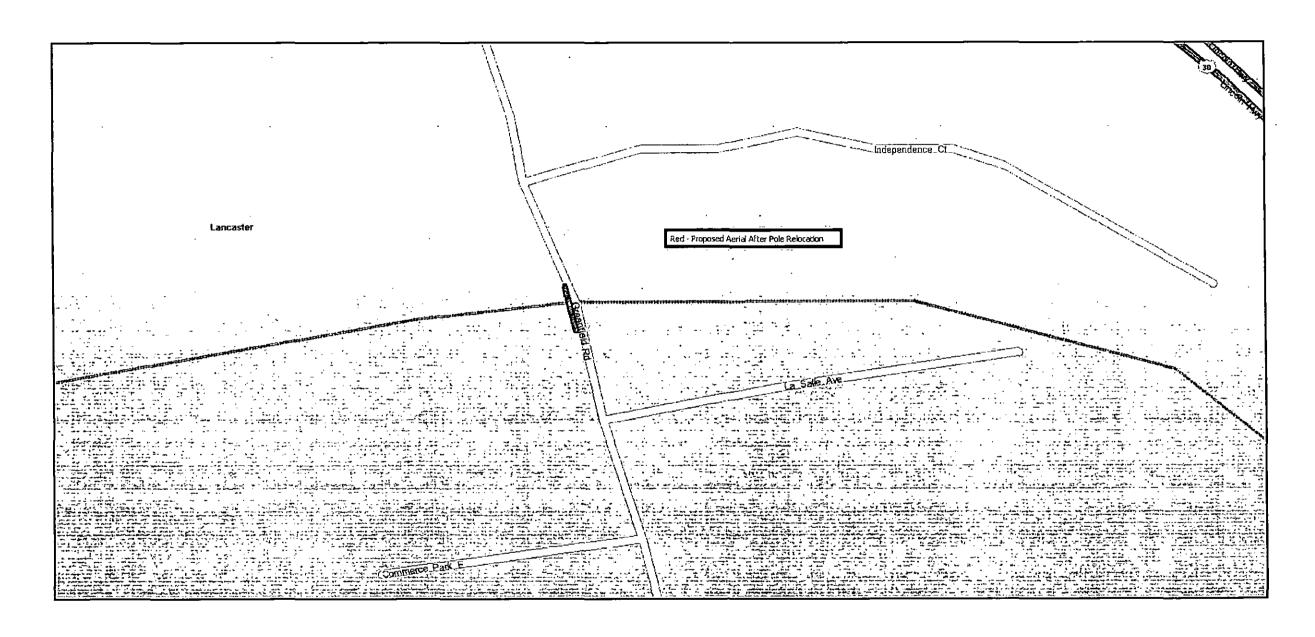



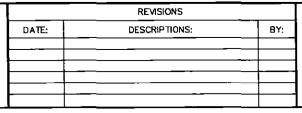



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Office	(610) 696-6910	·FAL	(610) 696-6937

PROJECT MANAGER: SP	TITLE:		
ENGINEERED BY: TV	GREENFIEL	D ROAD POLE F	RELOCATION
DRAWN BY: DTL		LOCATION MAI	2
PRELIMINARY DATE	LANCASTE	ER, PA LANC	ASTER COUNTY
03/18/15	DRAWING NO: XO	_Greenfield_Rd_Pole_Re	eto_Location_Map
	ISSUE DATE:	SCALE: NONE	SHEET: 2 OF 9

TASK			
CODE	WORK DESCRIPT	TION EST.	ACT
XXXX	XXX	XXXLF	-
XXXX	XXX	XXXLF	
	-		
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XO SUPPLIED		
MATERIAL DESCRIPTION	EST.	ACT.
FIBER OPTIC CABLE	XXXLF	-
FIBER OPTIC CABLE TAGS	X EA	

WORK PLAN INDEX						
DWG #	DESCRIPTION	ISSUE DATE	ASBUILT DATE			
SHT 01	COVER SHEET					
SHT 02	LOCATION MAP	LOCATION MAP				
SHT 03	WORK PLAN INDEX					
SHT 04	CONTACT SHEET					
SHT 05	CONSTRUCTION & GENERAL NOTES					
SHT 06	SYMBOLS KEY					
SHT 07	TYPICAL AERIAL POLE DETAILS					
SHT 08	PROPOSED FIBER ROUTE					
SHT 09	PROFILE VIEW		-			
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REVISIONS					
DATE:	DESCRIPTIONS:	BY:			
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PROJECT MANAGER: SP	TITLE:	
ENGINEERED BY: TV	GREENFIELD ROAD	POLE RELOCATION
DRAWN BY: DTL	WORK PL	AN INDEX
PRELIMINARY DATE	LANCASTER, PA	LANCASTER COUNTY
03/18/15	DRAWING NO: XO_Greenfield_	Rd_Pole_Relo_TOC

ISSUE DATE:

SCALE: NONE SHEET: 3 OF 9

CONTACT SHEET

XO COMMUNICATIONS:

IMPLEMENTATION ENGINEER: SCOTT DREILING

1-610-842-4323

<u>UTILITIES</u>

ONE CALL SYSTEM (UTILITY LOCATES)

1-800-242-1776

ENGINEERING CONTRACTOR:

NAME OF FIRM: METROPOLITAN COMMUNICATIONS GROUP

1-610-696-6910

PROJECT MANAGER: SHAWN PERRIN

1-610-420-3211

OSP ENGINEER: TED VAUGHAN

1-215-692-0919

CONSTRUCTION CONTRACTOR:

NAME OF FIRM:

PROJECT MANAGER:

#-###-###-###

CITY GOVERNMENT

NAME

#-###-###-###



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DATE:	DESCRIPTIONS:	BY:		
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np ""	PROJECT MANAGER: SP	TITLE:		
	ENGINEERED BY: TV	GREENFIELD ROAD POLE RELOCATION CONTACT SHEET		
	DRAWN BY: DTL			
	PRELIMINARY DATE	LANCASTER, PA	LANCASTER COUNTY	
	03/18/15	DRAWING NO: XO_Greenfield	d_Rd_Pole_Relo_Contact_Sheet	
1		ISSUE DATE: SCALE	: NONE SHEET: 4 OF 9	

CONSTRUCTION NOTES:


- 1. ATTACH AT TOP COMMUNICATIONS POSITION UNLESS SPECIFIED OTHERWISE ON THE PRINTS.
- 2. ALL AERIAL DOMESTIC STRAND WILL BE 6.6M EXCEPT AS DESIGNATED IN THE PRINTS.
- ALL GUYING DOMESTIC STRAND WILL BE 6.6M OR AS SPECIFIED IN THE DRAWINGS.
- 4. STRAND WILL BE BONDED TO POWER GROUND AT EVERY AVAILABLE GROUND, IF NO GROUND PRESENT WITHIN 1000' PLACE NEW VERTICLE GROUND AND ROD
- 5. ALL ANCHORS WILL BE 6' LONG, DOUBLE-EYED, 10" SCREW TYPE.
- 6. NEW POLES WILL BE 30' CLASS 4 UNLESS OTHERWISE SPECIFIED.
- 7. ALL AERIAL CABLE WILL BE DOUBLE—LASHED USING TYPE 302 .045 STAINLESS LASHING WIRE.
- 8. CONTRACTOR IS RESPONSIBLE FOR SUPPLYING
 ALL MATERIALS WITH EXCEPTION OF FIBER
 OPTIC CABLE, WARNING TAGS, BURIED CABLE
 WARNING TAPE, AND OTHER MARKER POST SIGNS.
- 9. ALL CONDUIT WILL BE 4" ID SCHEDULE 40(i.e. PVC OR GIP), UNLESS SPECIFIED OTHERWISE.
- 10. ALL BURIED CONDUIT/CABLE WILL BE PLACED AT 36" MINIMUM COVER UNLESS SPECIFIED OTHERWISE ON THE CONSTRUCTION DRAWINGS.
- 11. ALL 90 DEGREE SWEEPS IN CONDUIT
 CONSTRUCTION WILL BE A MINIMUM 38.2" RADIUS
 UNLESS SPECIFIED OTHERWISE.
- 12. ALL CONDUIT MUST HAVE C-WIRE IN WITH INNERDUCT IN A CONTINUOUS PULL FROM START TO END OF CONDUIT, IF NOT ABLE A WATER TIGHT SPLICE CAN BE USED AT HANDHOLE/MANHOLE LOCATIONS
- 13. MAXIMUM PULLING TENSION ON CABLES IS 600 LBS.
- 14. PULLING EYE MUST BE USED, AND CORRECTLY ATTACHED TO CABLE VIA A 600 LB. BREAKAWAY SWIVEL.
- 15. MIMINUM BEND RADIUS FOR FIBER OPTIC CABLE IS EQUAL TO 20 TIMES THE DIAMETER OF THE CABLE.
- APPROPRIATE DUCT PLUGS WILL BE USED TO SEAL THE CONDUIT AND INNERDUCT.
- 17. PLACE CABLE TAGS ON FIBER/INNERDUCT AT POLES, MANHOLES, ON BOTH SIDES OF ALL PENETRATIONS AND ON AERAIL CABLE AT POLE ATTACHMENTS, COILS AND SPLICE LOCATIONS.

GENERAL NOTES:

- 1. THE CONTRACTOR MUST CONTACT PA ONE—CALL AT 1—800—242—1776 FOR LOCATION OF EXISTING FACILITIES PRIOR TO START OF CONSTRUCTION.
- 2. THE MAJOR PORTION OF THE WORK COVERED UNDER THIS SPECIFICATION WILL BE PERFORMED ON PUBLIC RIGHT OF WAY. THE SAFETY OF THE WORKERS AND THE PUBLIC SHALL BE CONSIDERED OF THE UTMOST IMPORTANCE. PENNDOT PUBLICATION 203 (WORK ZONE TRAFFIC CONTROL) SHALL BE CLOSELY FOLLOWED. WARNING DEVICES, GUARDS, FLASHERS, FLAGS, AND FLAGMEN SHALL BE USED AS REQUIRED TO PROVIDE ADEQUATE PROTECTION TO VEHICULAR TRAFFIC, THE PUBLIC AND WORKMEN. STATE LAWS, CITY AND COUNTY ORDINANCES RELATIVE TO WORKING HOURS, TRAFFIC CONTROL, WARNING SIGNALS, COLOR OF LENS IN FLASHERS, GUARDS, FLAGMEN, ETC. SHALL BE COMPLIED WITH WHEN WORKING ON OR NEAR ANY PUBLIC RIGHT OF WAY. ALL DEVICES MUST BE IN PLACE PRIOR TO THE START OF CONSTRUCTION AND SHALL BE MAINTAINED BY CONTRACTOR DURING CONSTRUCTION.
- ALL WORK SHALL BE PERFORMED IN ACCORDANCE WITH OSHA REGULATIONS. PARTICULAR EMPHASIS HAS BEEN PLACED ON THE REQUIREMENT TO SHORE OR SLOPE ALL EXCAVATIONS GREATER THAN FOUR FEET DEEP.
- 4. ALL KNOWN UNDERGROUND OBSTRUCTIONS ARE MARKED ON THE PLAN AND PROFILE DRAWINGS. HOWEVER, OTHER UTILITY OBSTRUCTIONS MAY EXIST. BEFORE ACTUAL CONSTRUCTION, EXACT LOCATION AND DEPTH OF ALL OBSTRUCTIONS MUST BE DETERMINED BY THE CONTRACTOR. PARTICULAR ATTENTION SHALL BE PAID TO DRAINAGE STRUCTURES AND AN EXTENSIVE BURIED TRAFFIC CONTROL SIGNAL WIRE NETWORK. IT WILL BE THE RESPONSIBILITY OF THE CONTRACTOR TO COORDINATE THESE ACTIVITIES. DAMAGE AND RESTORATION OF ANY UTILITIES OR ANY OTHER OBSTRUCTION WILL BE THE RESPONSIBILITY OF THE CONTRACTOR.
- 5. EXCAVATIONS SHALL BE LEFT OPEN OVERNIGHT ONLY IF ABSOLUTELY NECESSARY AND WITH THE REQUIRED APPROVAL OF INVOLVED STATE AND LOCAL AGENCIES. ANY EXCAVATION LEFT OPEN OVERNIGHT MUST BE SUITABLY MARKED AND PROTECTED BY BARRICADES.

- TEMPORARY FENCES, OR COVERED WITH 3/4" STEEL PLATING TO PROTECT THE GENERAL PUBLIC AND VEHICULAR TRAFFIC. STEEL PLATES PROVIDED BY CONTRACTOR WILL BE USED TO MAINTAIN VEHICULAR TRAFFIC AND INGRESS AND EGRESS TO DRIVE IN BUSINESSES DURING CONSTRUCTION.
- 6. NO OPEN FLAME, TORCH, LIGHTED CIGAR,
 CIGARETTE OR PIPE SHALL BE BROUGHT NEAR
 OR INTO AN OPEN MANHOLE. THIS RULE SHALL BE
 OBSERVED EVEN THOUGH TESTS INDICATE THAT
 THE ATMOSPHERE IS FREE OF COMBUSTIBLE GAS.
 MANHOLES MUST BE CONTINUOUSLY VENTILATED
 WHEN WORKING IN THEM.
- 7. XO PENNSYLVANIA, AND IT'S
 REPRESENTATIVES, RESERVE THE RIGHT TO
 STOP CONSTRUCTION IF, AT ANY TIME, IT DEEM
 THE WORK TO BE UNSAFE, INADEQUATE OR
 HAZARDOUS. WORK SHALL NOT BE RESUMED
 UNTIL AGREEABLE MEASURES HAVE BEEN TAKEN
 TO RESOLVE THE PROBLEM.
- 8. ANY AND ALL IMPROVEMENTS, SUCH AS ASPHALT OR CONCRETE PAVEMENT, CURBS, GUTTERS, WALKS, DRAINAGE DITCHES, EMBANKMENTS, SHRUBS, TREES, GRASS SOD, ETC., IF DAMAGED, SHALL BE RESTORED TO ORIGINAL OR BETTER CONDITION.
- 9. EQUIPMENT TYPES SPECIFIED HEREIN (i.e. BACKHOE, TRENCHER, ETC.) ARE SUGGESTIONS ONLY AND ARE NOT INTENDED AS REQUIREMENTS. CONTRACTOR SHOULD ANTICIPATE "HAND TRENCHING" AS REQUIRED BY OTHER UTILITY OWNERS.
- 10. ALL WORK TO BE PERFORMED IN STRICT ACCORDANCE WITH THE APPLICABLE CODES OR REQUIREMENTS OF ANY REGULATING GOVERNMENT AGENCY, XO PENNSYLVANIA, OR RIGHT-OF-WAY GRANTOR.



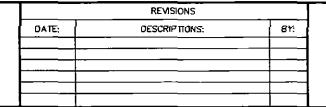





919 Camaro Ran Drive, West Chester, PA 19340 Office: (610) 696-6910 - Fax. (610) 696-6937

PROJECT MANAGER: SP	TITLE:
ENGINEERED BY: TV	GREENFIELD ROAD POLE RELOCATION
DRAWN BY: DTL	CONSTRUCTION & GENERAL NOTES
PRELIMINARY DATE	LANCASTER, PA LANCASTER COUNTY
03/18/15	DRAWING NO: XO_Greenfield_Rd_Pole_Relo_General_Notes

SCALE: NONE

SHEET: 5 OF 9

ISSUE DATE:

SYMBOLS KEY

	<u>EXISTING</u>		EXISTING	PROPOSED		EXISTING	PROPOSED
NORTH ARROW		RAILROAD CROSSING SIGNAL	4		RAILROAD TRACKS	+++++++++++++++++++++++++++++++++++++++	
POWER POLE	×				FENCE	~x - x - x - x - x -	-x-x-x-x-
TELEPHONE POLE	0	MILE MARKER POST	*		GUARDRAIL		
JOINT POLE	\otimes				CENTERLINE		
TRANSFORMER ON POLE .	\Bar{\Bar{\Bar{\Bar{\Bar{\Bar{\Bar{	BRIDGE			FACE OF CURB	FOC	
CABLE TV POLE	•	TREE	(-)		EDGE OF PAVEMENT	EOP	
CONCRETE POLE	(C)	BUSH	0		BACK OF CURB	вос	
STEEL POLE	(S)	CAUTION NOTE	CAUTION C		RIGHT-OF-WAY		
PEDESTAL	6	TOP OF SLOPE	BURIED FIBER OPTIC CABLE		CITY, COUNTY OR STATE BOUNDARY LINE		
POLYMER CONCRETE HANDHOLE		BOTTOM OF SLOPE			PROPERTY LINE	P/L	
ELECTRIC MANHOLE	Ē	DITCH LINE	D/L		UNDERGROUND GAS LINE	G G	
SEWER MANHOLE	S	FOOTAGE	#		UNDERGROUND WATER LINE	w w	
STORM MANHOLE	ST	OVERHEAD GUY			UNDERGROUND ELECTRIC LINE	— E — E —	
TELEPHONE MANHOLE	Ī	SLACK SPAN			UNDERGROUND TELCOM LINE	- 	
WATER MANHOLE	W	PUSH BRACE	— ⊸ ₽8		UNDERGROUND CATV	CATV CATV	
UNKNOWN MANHOLE	UN	POLE TO POLE GUY			UNDERGROUND SEWER LINE	s s	
FIRE HYDRANT (FH)	€}	ANCHOR & GUY	→ <	→ <	UNDERGROUND STORM DRAIN LINE	st st	
STREET LIGHT (SL)	×	SIDEWALK ANCHOR & GUY	-	→ A	TRENCH FIBER OPTIC CABLE		
TRAFFIC LIGHT (TL)	← ≭	ANCHOR ONLY	₹`	<``	AERIAL FIBER OPTIC CABLE		
GAS VALVE (GV)	Q	FIBER SPLICE	\triangleright	~	REMOVE CABLE		
WATER VALVE/METER (WV/WM)	. 🕀	FIBER SLACK COIL (AERIAL)	\sim	\sim	CONCRETE ENCASED		
ELECTRIC VAULT		<u>SLACK COIL</u> (##=FOOTAGE)	SC ##		DIRECTIONAL BORE		08
GROUND	Ť	(##=FUUTAGE)	##/		JACK AND BORE		
CATCH BASIN		FIBER TAIL	_		TEST PIT		•
CULVERT (SIZE AS INDICATED)	<u> </u>						-



RAILROAD SIGNAL

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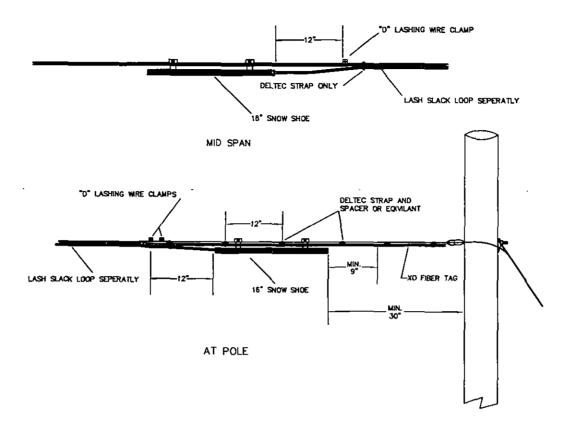
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SYMBOLS KEY	


LANCASTER, PA LANCASTER COUNTY DRAWING NO: XO_Greenfield_Rd_Pole_Relo_Symbols_Key


ISSUE DATE: SCALE: NONE SHEET: 6 OF 9


LASHING & SNOW SHOE PLACEMENT



POLE DETAILS

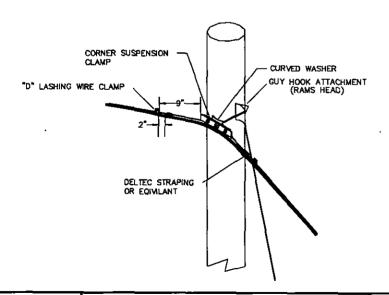

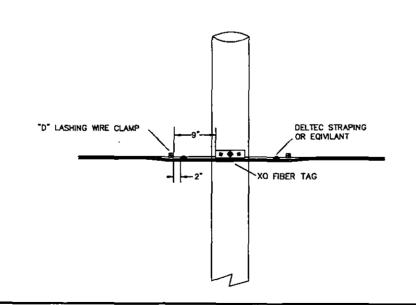

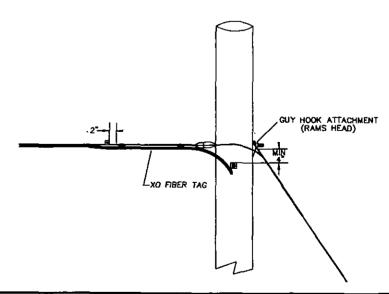

CALL BEFORE YOU DIG 3-800-242-1776 2 HOURS NOTICE REQUIRED	

REVISIONS				
DATE:	DESCRIPTIONS:	BY:		
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XC.	communications
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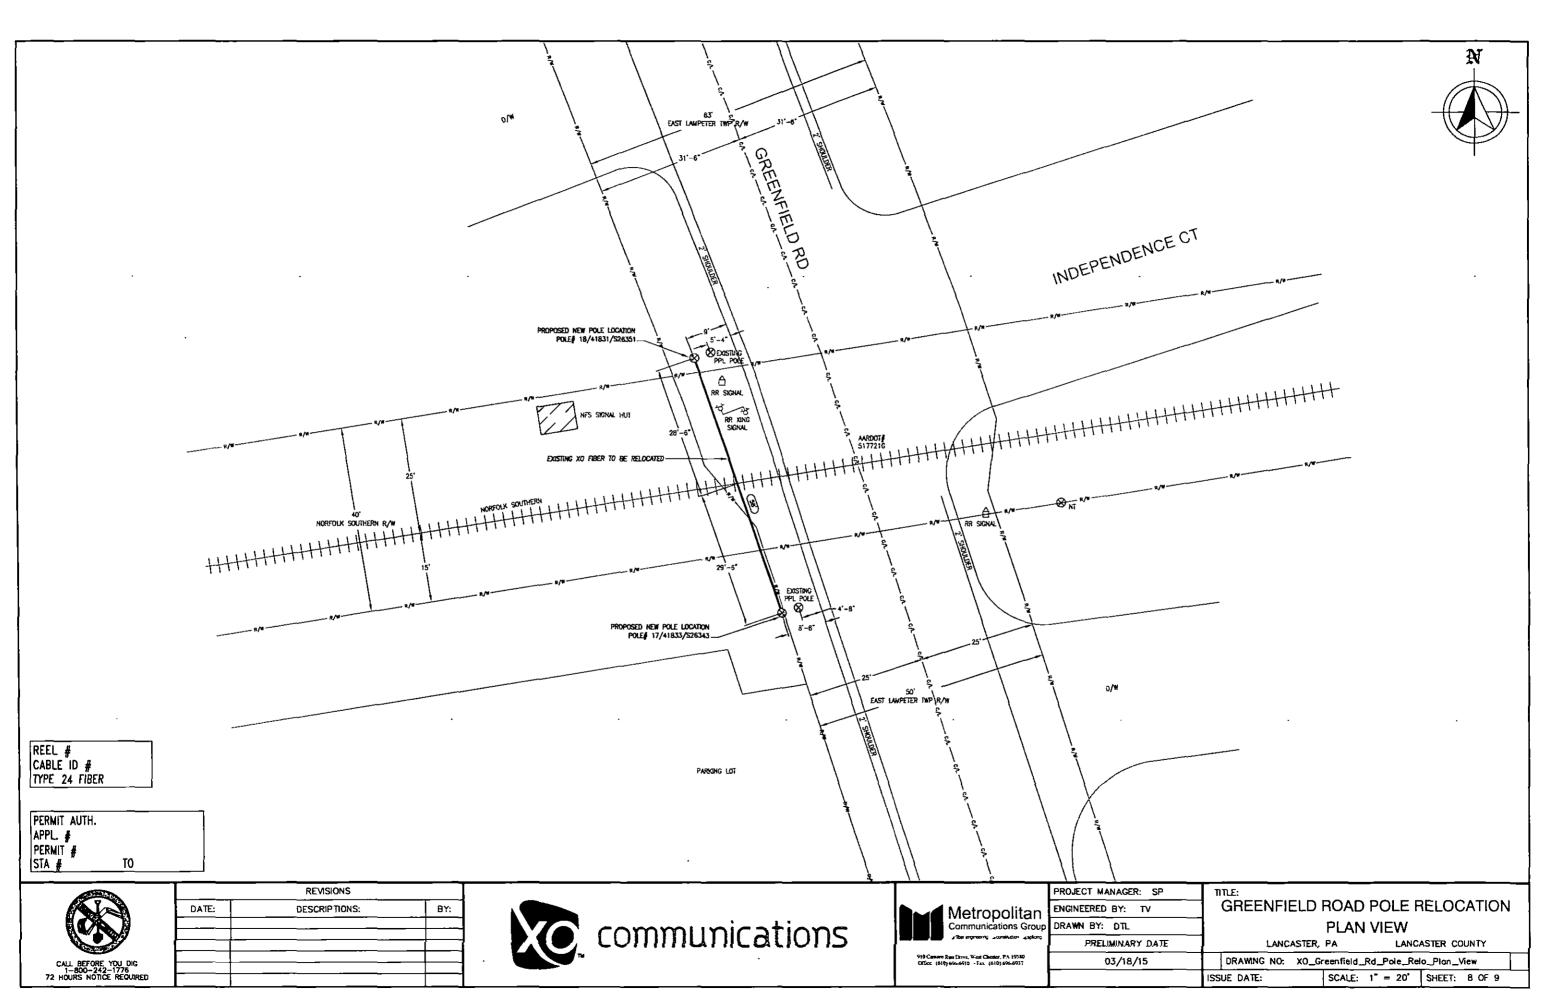
Metropolitan Communications Group
918 Camero Rue Drive, West Oberacy, PA 19310


PROJECT MANAGER: SP	TITLE:				
ENGINEERED BY: TV	GREENFIELD ROAD POLE RELOCATION				
DRAWN BY: DTL	TYPICAL AERIAL POLE DETAILS				
PRELIMINARY DATE	LANCASTER, PA LANCASTER COUNTY				
03/18/15	DRAWING NO: XO_Greenfield_Rd_Pole_Reio_Typ_Aerial_Dtls				

SCALE: NTS

SHEET: 7 OF 9

ISSUE DATE:



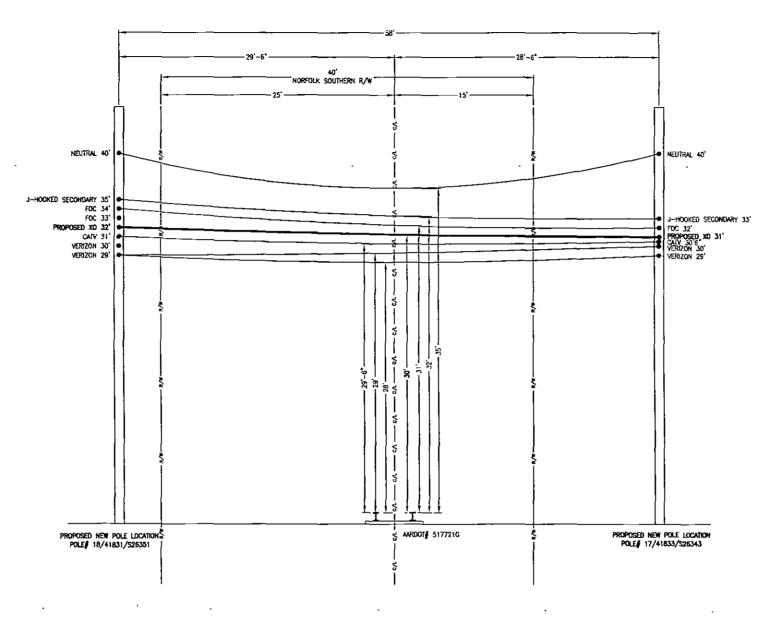

REEL # CABLE ID # TYPE 24 FIBER

PERMIT AUTH.
APPL. #
PERMIT #
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TO

PROFILE VIEW FACING EAST

NOTE:

APPROX. ATTACHMENT HEIGHTS AFTER PPL POLE RELOCATION.



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	Metropolitan Communications Group	
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	910 Carnaro Ross Dirivo, West Chester, PA (9380	1

PROJECT MANAGER: SP	TITLE:				
ENGINEERED BY: TV	GREENFIELD ROAD POLE RELOCATION				
DRAWN BY: DTL	7	PROFILE VIEW			
PRELIMINARY DATE	LANCA	ASTER, PA	LANC	ASTER COUNTY	
03/18/15	DRAWING NO:	XO_Greenfield_F	d_Pole_Re	lo_Profile_View	
	ISSUE DATE:	SCALE	1" = 10"	SHEET 9 OF 9	_



.910 Camaro Run Drive West Chester, PA 19380

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FROM: PHIL SEEHERMAN (610) 696-6910 METROPOLITAN COMMUNICATIONS GR 910 CAMARO RUN DRIVE WEST CHESTER PA 19380-4281

SHIP TO:

MS. ROSEMARY CHIAVETTA PA PUBLIC UTILITY COMMISSION **SECRETARY** P.O. BOX # 3265 **HARRISBURG PA 17105-3265**

CMPC

CHIAVETA, R. PUC

TO:

PUC

Agency


Floor:

UPS GROUND

External Carrier:

4/6/2015 9:25:56 AM



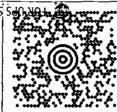

PA 171 9-20

UPS GROUND

TRACKING #: 1Z W80 195 03 4071 3945



BILLING: P/P

ISSION